

March 2, 2012

Oregon Public Utilities Commission 550 Capital St NE #215 PO Box 2148 Salem, OR 97308-2148

RE: EXPIDITED REQUEST for a waiver of the 12-month installation requirement (OAR 860-084-2010 (1) for the Portland General Electric (PGE) Solar Payment Option program.

To Whom It May Concern:

Christenson Electric is submitting this request on behalf of Ponzi Vineyards which has a Portland General Electric Solar Payment Program reservation (9C98BB) and a system completion date of April 12, 2012.

Specifically, we are asking for a 30-day extension to allow time for system completion.

General Information

The system in question is a 10kW roof mounted system will be located on the roof of the Ponzi Vineyards winery building located at 19500 SW Mountain Home Rd, Sherwood, OR 97140.

Circumstances in Request

All things being equal, we are very confident in our ability to install the system in a timely manner. However, there were a few minor delays during the previous 12 months which, when added together, caused us concern over timing. With our experience in the building and electrical permit process for this jurisdiction (Washington County) along with the possibility of inclement weather during installation we feel a small extension is the prudent path for the ratepayer. These delays included the customer desire to see the results of the BETC rulemaking process. A favorable BETC process would have allowed them to build a larger system. But in the last few weeks, it became apparent that the new BETC rules were going to be very difficult. In addition, there were some extended discussions within the Ponzi Vineyards management as to the right system design. The aesthetics of the building are extremely important to the Ponzi brand. Those discussions are complete per the attached drawing set and we are ready to proceed.

The following work has been completed:
Interconnection application (attached)
System design (attached)
Structural engineering review (attached)
Permit applications (attached)

We are hoping that these circumstances and along with the short extension request will help the commission find in our favor.

Please let us know if any further information would be helpful in your evaluation of our request.

On behalf of Ponzi Vineyards,

Respectfully submitted,

Alan Hickenbottom General Manager, Energy Services Group

# Solar Payment Option System Application for Level 1 Interconnection



(Applies to a photovoltaic system with 25 kW or less DC nameplate capacity)

<b>Customer Information:</b>			
Tracking No. (provided with notification	of Capacity Reservation	Date): 9C98BB	***************************************
Name: LUISA PON	)Z1		
Company Name (if applicable): PONZ	ZI VINEYARDS		
Mailing Address: 14665 SW WINER			
	State: OR Zip Co	de: 97007	
Daytime Telephone: 503-628-8080	Cell/Evening:		
E-Mail: LUISA@PONZIWINES.CO			
Facility Information:			
Existing Account where backfeed will	occur (from PGE bill):	468286-872725	
Estimated Commissioning Date (when sys			01/11
Location (if different from Applicant's Street Address: 19500 MOUNTAIN	address listed above):		
City: SHERWOOD	Stat	e: OR Zip Code: 97	140
Service Voltage: 277/480 Volts	Single-Phase	3-Phase	
Generator Nameplate Capacity (STC kW			DC kW
System Installer Information (must b Company Name: CHRISTENSON EL		Ally):	
Contact Name: MAT ELMORE			
Contractor License No. 458	_ Electrical Supervisor:		
Mailing Address: 111 SW COLUMBIA			
City: PORTLAND	State: OR Zip Co	<sub>de:</sub> 97201	
Office Telephone: 503-892-5726	Cell: 503-333		
E-Mail: MAT.ELMORE@CHRISTEN	ISON.COM		

(Continued on next page)

SOLAR PAYMENT OPTION SYSTEM APPLICATION FOR LEVEL 1 INTERCONNECTION Page 1 of 3

Inverter Information:			
Inverter Manufacturer: SOLECTRIA	Model: PVI 10K	Ν	
Total Number of Inverters: 1		······································	
	Max. Capacity per		_AC kW output
Phase: Single Three	Inverter Output Vo	oltage: 480	AC Volts
Inverter specifications sheet (manufact Note: If inverter is not lab-certified by then a Level 3 Interconnection Applica	a Nationally Recogni	zed Testing Labora	tory (NRTL),
Additional Documents:			
Disconnect Determination.		May AC Output	illawal with auto
Does AC generation capacity	Service Type	Max. AC Output A	
exceed 30 amps (see chart)?	240 Volts, Single-Phase,	3 Wire: 7.2 kW	
	120/208 Volts, 3-Phase, 4		
∐ yes	120/240 Volts, 3-Phase 4	<del></del>	
no L	277/480 Volts, 3-Phase 4	Wire: 25.0 kW	
If yes, your site requires a readily accessive require two drawings:  i) a one-line electrical diagram meter, including new production ii) a site plan showing to-scale meter, and new PGE production other arrangements have been meters.	n showing full circuit in meter, disconnect, a the proposed location in meter. Distance is to	from solar panels all protective device of the disconnect,	to existing PGE es, etc., and existing PGE
Estimated Energy Generation:  Systems applying for participation in the Steps than existing service's annual usage. It posses upon the rolling average of three Annual kilowatt-hours (kWh) production with the methodologies used by the Energy System Production Estimates.	If annual usage is una ee years' usage by a s on estimate must use a Trust of Oregon and th	vailable, it will be similarly situated si a forecasting methole e Oregon Department	estimated by te. <sup>l</sup> dology consistent t of Energy.

<sup>&</sup>lt;sup>1</sup> The eligible system is limited to 90 percent of the electric site's previous usage. You can find information about approximate expected generation by visiting the Energy Trust of Oregon web site at <a href="http://energytrust.org/shared-resources/solar-calculator/">http://energytrust.org/shared-resources/solar-calculator/</a>. The solar calculator helps you determine how much electricity you can expect to produce, although your Energy Trust Trade Ally will provide a more accurate estimate to complete this application.

Printed Name: \_\_\_

Management of the contract of	503,419
Customer Consent to Data Release	
I hereby acknowledge and agree that PGE may release information concerning Oregon Department of Revenue, the Oregon Department of Energy, the Oregon Department of Oregon. PGE shall use reasonable efforts to pursue appropriagencies and organizations.	on Public Utility Commission and the
Customer Signature:	
I hereby attest that the information submitted on this application is accurate to the system is to be constructed from new components and compliant with Oregon Pureliability requirements for photovoltaic systems, value certify that the system will, 2010.	blic Utility Commission quality and il be first operational and online after July
Applicant Signature:	_ Date: _5 • /3 · //
Printed Name: Title (if app	licable): Ou NO
Mail Completed Interconnection Application to:	
PGE Solar Payment Option	
PO Box 4079	• •
Portland, OR 97208-4079	
	\$** · ·
Interconnection Application Receipt Acknowledgement:	
Receipt of a completed application is hereby acknowledged.	A STATE OF THE STA
Approval for a Level 1 Solar Payment Option System interconnection is con Facility passing the Level 1 screens and completing the review process set forth i is not granted by the utility's receipt acknowledgement signature on this Ap notified within ten (10) business days of receipt of this acknowledgment whapproved or denied.	n OPUC Rule AR 538, Division 084 and plication Form. The Applicant will be
Utility Signature:	Date:
Printed Name: Title:	THE THE PROPERTY OF THE PROPER
Interconnection Application Approval:	*
Utility Signature:	Date:

SOLAR PAYMENT OPTION SYSTEM APPLICATION FOR LEVEL 1 INTERCONNECTION Page 3 of 3

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111 SW Fifth Avenue Suite 2500 Portland, OR 97204 (503) 227-3251 (503) 227-7980 FAX

## AGREEMENT FOR PROFESSIONAL SERVICES

<b>DATE:</b> March 1, 2012	<b>JOB NUMBER:</b> 212127
CLIENT:	Christenson Electric, Inc.
PROJECT NAME:	Ponzi Winery – Roof PV Installation
LOCATION:	Sherwood, OR
SCOPE OF SERVICES:	Review existing winery building to support a 10kW PV solar array. Scope includes review of existing structure and connections. Structural information will be marked-up on Christenson drawing set as required.
SPECIAL CONDITIONS:	N/A
FEE:	\$1,150
Offered By (KPFF, Inc.)	Accepted by (Christenson Electric)
Office	
(Signature)	(Signature)
Josh Richards, S.E. / Asso	Jeff Zimmerman  (Brinted Name and Title)

Please sign in the space provided and return to our office for our signature. We will return a fully executed copy of the Agreement to you for your records.

## **TERMS AND CONDITIONS**

KPFF, Inc. ("KPFF") shall perform the services outlined in this agreement pursuant to the stated fee arrangement.

## 1. Additional Services

Should the Scope of Services change from those set forth in the Agreement for Professional Services, the fee for such additional services will be negotiated between Client and KPFF.

## 2. Limitation of Liability

To the greatest extent allowed by law, the aggregate liability of KPFF for any and all injuries, claims, demands, losses, expenses or damages, of whatever kind, arising out of or in any way related to this Agreement or the services provided by KPFF on this project, shall be limited to \$25,000 or the total fee received by KPFF pursuant to this Agreement, whichever is greater. Further, no officer, director, shareholder or employee of KPFF shall bear any personal liability to Client for any and all injuries, claims, demands, losses, expenses or damages, of whatever kind or character, arising out of or in any way related to this Agreement or the services provided by KPFF on this project.

### 3 Mediation

All disputes between Client and KPFF arising out of or relating to this Agreement shall be submitted to nonbinding mediation prior to commencement of any other judicial proceeding.

## 4. Dispute Handling

KPFF shall make no claim against Client without first providing Client with a written notice of damages and providing Client thirty (30) days to cure before an action is commenced. The Client shall make no claim either directly or in a third party claim, against KPFF unless the Client has first provided KPFF with a written certification executed by an independent professional currently practicing in the same discipline as KPFF and licensed in the state of the subject project. This certification shall a) contain the name and license number of the certifier; b) specify each and every act or omission that the certifier contends is a violation of the standard of care expected of a professional performing professional services under similar circumstances; and c) state in complete detail the basis for the certifier's opinion that each such act or omission constitutes such a violation. This certificate shall be provided to KPFF not less than thirty (30) calendar days prior to the presentation of any claim or the institution of any judicial proceeding.

## 5. Suspension of Services

If Client fails to make payments to KPFF in accordance with this Agreement, such failure shall provide KPFF the option to suspend performance of services under this Agreement upon seven (7) days written notice to Client. In the event of a suspension of services, KPFF shall have no liability for any delays or damages caused because of such suspension. Before resuming services, KPFF shall be paid all sums due prior to suspension and any expenses incurred by KPFF in the interruption and resumption of its services. KPFF's fees for the remaining services and time schedules shall be equitably adjusted. If any invoice is in dispute, Client shall pay under written protest to keep the project on schedule and resolve the payment dispute after substantial completion.

## 6. Termination

This Agreement may be terminated by either party with seven (7) days written notice to the other in the event of a substantial failure of performance by the other party through no fault of the terminating party. If this Agreement is terminated, KPFF shall be paid for services performed to the termination notice date, including reimbursable expenses due.

## 7. Ownership of Documents

All documents produced by KPFF are instruments of service and are, and shall remain, the property of KPFF, whether the project for which they are made is executed or not. They are not to be used on other projects or extensions to this project except by agreement in writing.

## 8. Contract Administration

It is understood that KPFF will <u>not</u> provide design and construction review services relating to safety measures of any contractor or subcontractor on the project. Further, it is understood that KPFF will <u>not</u> provide any supervisory services relating to the construction for the project. Any opinions solicited from KPFF relating to any such review or supervisory services shall be considered only as general information and shall not be the basis for any claim against KPFF.

## 9. No Third Party Beneficiary

Nothing in this Agreement shall create a contractual relationship with or a cause of action in favor of any third party against KPFF or Client.

## 10. No Assignments

Neither party to this Agreement shall transfer, sublet or assign any rights under or interest in this Agreement (including but not limited to monies that are due or monies that may be due) without the prior written consent of the other party.

## 11. Payments

KPFF will submit monthly invoices. Payment is due on the date of the invoice and becomes delinquent one month thereafter. A late charge will be added to delinquent amounts at the rate of one-and-one-half percent (1-½ %) for each one month of delinquency (or the maximum allowable by law, whichever is lower). If KPFF initiates suit to recover delinquent sums owed by Client, KPFF shall be entitled to recover all reasonable costs incurred, including staff time, court costs, attorney's fees, expert fees and other related costs and expenses.

Authorized signature:

Print name:

## **Building Permit Application**

Washington County Phone: 503-846-3470, Fax: 503-846-3993, Inspection Request: 503-846-3699

155 N. 1st AV, Suite 350, MS 12, Hillsboro, OR 97124

www.co.washington.or.us Permit#

Project # Land Use Approval: TYPE OF WORK □ Demolition ■ New construction Other: ☑ Addition/alteration/replacement CATEGORY OF CONSTRUCTION ✓ Commercial/industrial ☐ 1- and 2-family dwelling Multi-family ☐ Accessory building JOB SITE INFORMATION AND LOCATION Job site address: 19500 SW Mountain Home Road City/State/ZIP: Sherwood, OR 97140 Project name: Collina del Sogno Suite/bldg./apt. no.: Cross street/directions to job site: on Mountain Home Road about 1.2 miles south of highway 219 Reissue: Yes 🗖 No 🔲 Plan No. Lot no.: Subdivision: Tax map/parcel no .: DESCRIPTION OF WORK Install a 9.9kW solar array on the roof of an existing building. ☐ TENANT PROPERTY OWNER Name: Address: City/State/ZIP: Fax: ( Phone: ( ✓ CONTACT PERSON APPLICANT Business name: See CONTRACTOR below Contact name: Jeff Zimmerman Address: City/State/ZIP: Fax::(503)419-3743 Phone: (503)419-3643 E-mail: jeff.zimmerman@christenson.com CONTRACTOR Business name: Christenson Electric, Inc. Address: 111 SW Columbia, Ste. 480 City/State/ZIP: Portland, OR 97201 Fax: (503)419-3743 Phone: (503)419-3643 CCB lic.: 458 Architect: Engineer: KPFF Address: Address: 111 SW fifth Ave., Ste. 2500 Portland, OR 97204 Phone:( Phone: (503)227-325 Email: Email:

REQUIRED DATA: 1- Al	ND 2-FAMILY DWELLING
Permit fees* are based on the	value of the work performed. o the nearest dollar) of all overhead, and the profit for the
Valuation	
Number, of bedrooms:	
Number of bathrooms:	
Total number of floors:	
New dwelling area:	square feet
Garage/carport area:	square feet
Covered porch area:	square feet
Deck area:	square feet
Other structure area: 850	square feet
REQUIRED DATA: COM	MERCIAL-USE CHECKLIST
Valuation : PV structural r  Existing building area:	acking \$12,995.00 square feet
New building area:	square feet
Number of stories:	
Type of construction:	
Occupancy groups:	
Existing:	
New:	TO THE PERSON LIGHTLY
	OTICE
under ORS 701 and may be	Construction Contractors Board e required to be licensed in the
BUILDING	PERMIT FEES*
Please ref	er to fee schedule
Fees due upon application	\$378.79
Amount received	\$

This permit application expires if a permit is not obtained within 180 days after it has been accepted as complete.

Fee methodology set by Tri-County Building Industry Service Board

Date received:

440-4613T (8/06/COM/WEB)



## Renewable Electrical Energy Permit Application

Department of Land Use and Transportation Building Services Section

155 N. 1st Avenue, Suite 350, MS 12 Hillsboro, OR 97124 (503) 846-3470, Fax: (503) 846-3993 www.co.washington.or.us

To the second	DEPARTMENT USE ONLY
Project	No.:
Permit N	lo:
By:	Date:
	OCAL GOVERNMENT APPROVAL
Zoning a	approval verified?

This permit is issued under OAR 918-309-0410. Permits are non-transferable. Permits expire if work is not started within 180 days of issuance or if work is suspended for 180 days.

JOB SITE INFORMATION	ON AND LOCATION
Job site address: 19500 SW Mou	untain Home Road
City/State/ZIP: Sherwood, Oreg	jon 97140
Tax Map & Lot No:	
Project name: Collina del Sogno	o PV Array
Directions to job site: 21	9 south 11 miles,
left on Mt. Home Rd., 1.2	miles (Ponzi Vineyards)
Subdivision:	Lot no.:
DESCRIPTION	OF WORK
Install 9.9kW roof mou	nt, grid tied PV array
Job no.:	
PROPERTY OWNER	R INSTALLATION
Name:	
Address:	
City/State/ZIP:	
Contact phone: ( )	E-mail:
This installation is being made on reby me or a member of my immediat intended for sale, exchange, lease, o 479.560(1)]	e family. This property is not
Sign here:	
CONTRACTOR IN	ISTALLATION
Business name: Christenson El	ectric, Inc.
Address: 111 SW Columbia,	Ste. 480
City/State/ZIP: Portland, OR 9	
Contact phone: ( 502) 419.364	3 Fax: (503)419.3743
E-mail: jeff.zimmerman@chi	
CCB lic.: 458	CD lic. no.: 26-34C
Signature:	Druene
Name of signing supervisor	A Ruy amplic. no. 5215

Number of inspections per item = ( )	No. of items	Cost each	Sum
ALL Renewable energy installations per	system-t	otal up to 2	5 KVA
5 KVA or less (2)		\$90.50	\$ 0.00
5.01 to 15 KVA (2)	1	\$120.50	\$ 120.50
15.01 to 25 KVA (2)		\$182.00	\$ 0.00
Wind generation system over 25 KVA			
25.01 to 50 KVA (3)		\$271.00	\$ 0.00
50.01 to 100 KVA (3)		\$507.50	\$ 0.00
100.1 KVA and over: OAR 918-309-0040		indard electr or feeder <b>fe</b>	
Service or feeders in amps per OAR	918-309	-0040	
200 amps or less (2)	1	\$95.75	\$ 95.75
201 amps to 400 amps (2)		\$127.00	\$ 0.00
401 amps to 600 amps (2)		\$191.00	\$ 0.00
601 amps to 1,000 (2)		\$286.00	\$ 0.00
Over 1,000 amps or volts (2)		\$535.00	\$ 0.00
Each branch circuit with above service or feeder(s).	4	\$9.00	\$ 36.00
Solar generation system over 25 KVA			
Each KVA over 25.01 up to 100 KVA (3)		\$6.25	\$ 0.00
100.01 KVA and over no additional fee. [OAR 918-309-0070 (11)(c)(B)]	I	No additional fee	
Each additional inspection (1) OAR 918-309-0070		\$105.00	\$ 0.00
Miscellaneous fees, hourly rate		\$105.00	\$ 0.00
FEE TOT.	ALS		ALC: NO
(A) Subtotal of above fees		\$ 25	52.25
(B) State surcharge. 12% of subtotal.		\$ 3	0.27
(C) Plan review required for systems o KVA at 25% of (A). (No 12% surch	ver 25 narge)	\$	
Total fees and sur	charges:	\$ 28	32.52

Make checks or money orders payable to Washington County.

Credit card payments are accepted in person or by submitting our "Credit Card Authorization" form along with this application. (Located under "Payments & Fees, Payment Options" on our website)

# PHOTOVOLTAIC SYSTEM PONZI VINEYARDS - COLLINA DEL SOGNO 19500 SW MOUNTAIN HOME RD. SHERWOOD, OREGON 97140

# **OWNER**

PONZI VINEYARDS

19500 SW MOUNTAIN HOME RD.

SHERWOOD, OREGON 97140

503.628.1227

# PROJECT MANAGER

CHRISTENSON ELECTRIC
111 SW COLUMBIA, SUITE 480
PORTLAND, OREGON 97201
503.419.3330

# GENERAL/ELECTRICAL CONTRACTOR

CHRISTENSON ELECTRIC
111 SW COLUMBIA, SUITE 480
PORTLAND, OREGON 97201
503.419.3330

# STRUCTURAL ENGINEER

KPFF CONSULTING ENGINEERS

111 SW FIFTH AVENUE, SUITE 2500

PORTLAND, OREGON 97204

503.227.3251

# SYSTEM DESIGN

TANNER CREEK ENERGY

111 SW COLUMBIA, SUITE 480

PORTLAND, OREGON 97201

503.892.5726

# SYSTEM DESCRIPTION

(44) SOLARWORLD 225 POLY PV MODULES(1) POWER-ONE AURORA TRIO 10kW INVERTER9,900 WATTS DC STC

# SCOPE OF WORK

THE PROJECT SCOPE INCLUDES THE DESIGN AND INSTALLATION OF A 9,900 W DC GRID—TIED SOLAR PHOTOVOLTAIC (PV) SYSTEM AT PONZI VINEYARDS IN SHERWOOD, OREGON.

THE PV SYSTEM CONSISTS OF ONE NON-COMBUSTIBLE ROOF MOUNTED SOLAR ARRAY, ONE INVERTER AND RELATED ELECTRICAL EQUIPMENT.

DURING DAYLIGHT HOURS THIS PV SYSTEM WILL PROVIDE ELECTRICITY IN PARALLEL WITH THE LOCAL ELECTRIC UTILITY SERVICE PROVIDER.

ALL EQUIPMENT WILL BE INSTALLED AS REQUIRED BY
APPLICABLE CODES (2010 OREGON SOLAR INSTALLATION
SPECIALTY CODE) AND PORTLAND GENERAL ELECTRIC
SOLAR PAYMENT REQUIREMENTS.

	SHEET LIST TABLE
Т	TITLE PAGE & SITE PLAN
А	LAYOUT & ELEVATION
E.1	ELECTRICAL NOTES & PLAN
E.2	ELECTRICAL DIAGRAM
E.3	SIGNAGE
S.1	RACKING SUPPORT
S.2	RAIL & MODULE LAYOUT
S.3	RACKING DETAILS
	A E.1 E.2 E.3 S.1 S.2







Sheet Number:

7

DESIGN



Revision

ARDS - COLLINA DEL SOTOVOLTAIC PROJECT

SW Mountain Home Rd.

Sheet Title:
TITLE PAGE +
SITE PLAN


Date: 02/24
CEI Project No.
CEI Project Manager:


Designed By:
Drawn By:


Drawn By: Checked By:

Cnecked By: Project Type:

S'	YSTEM DESCRIPTION
MODULE TYPE	SOLARWORLD 225 POLY
QUANTITY	44 MODULES
SYSTEM SIZE	9.9 kW DC STC
TILT ANGLE	17°
AZIMUTH	180°
INVERTER	POWER-ONE AURORA TRIO 10kW

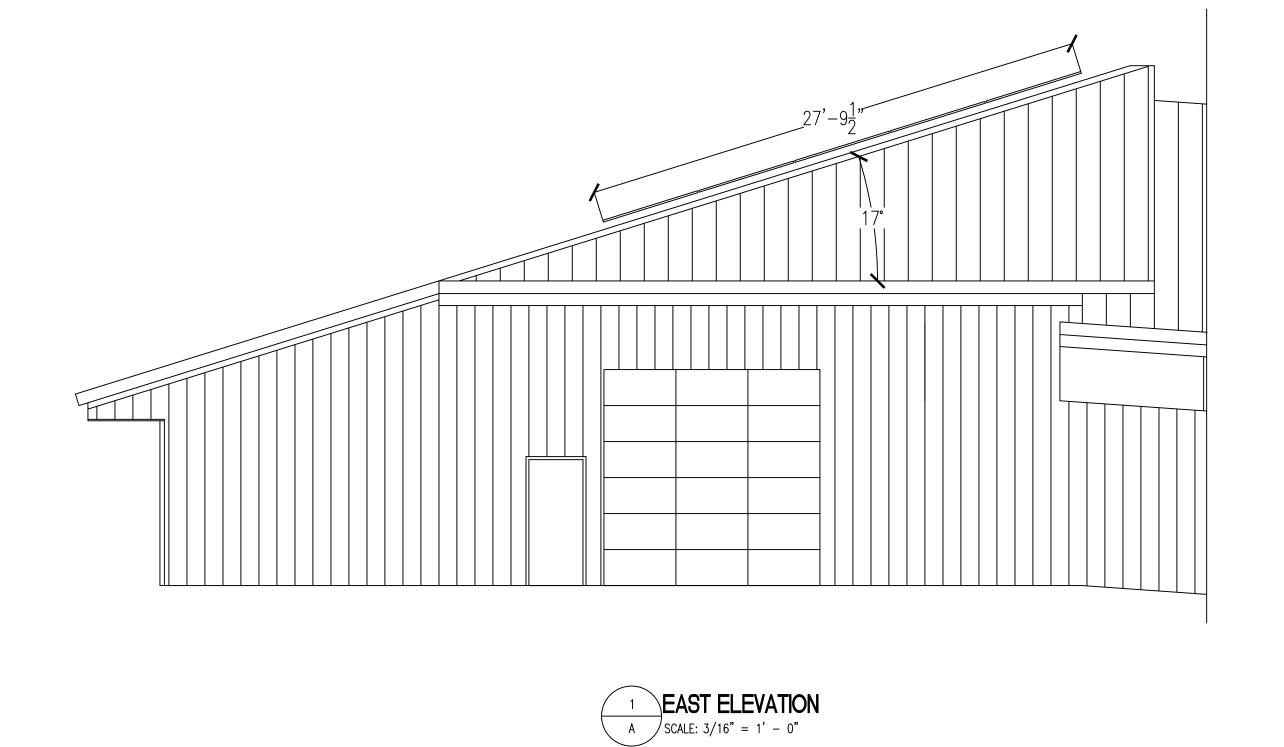

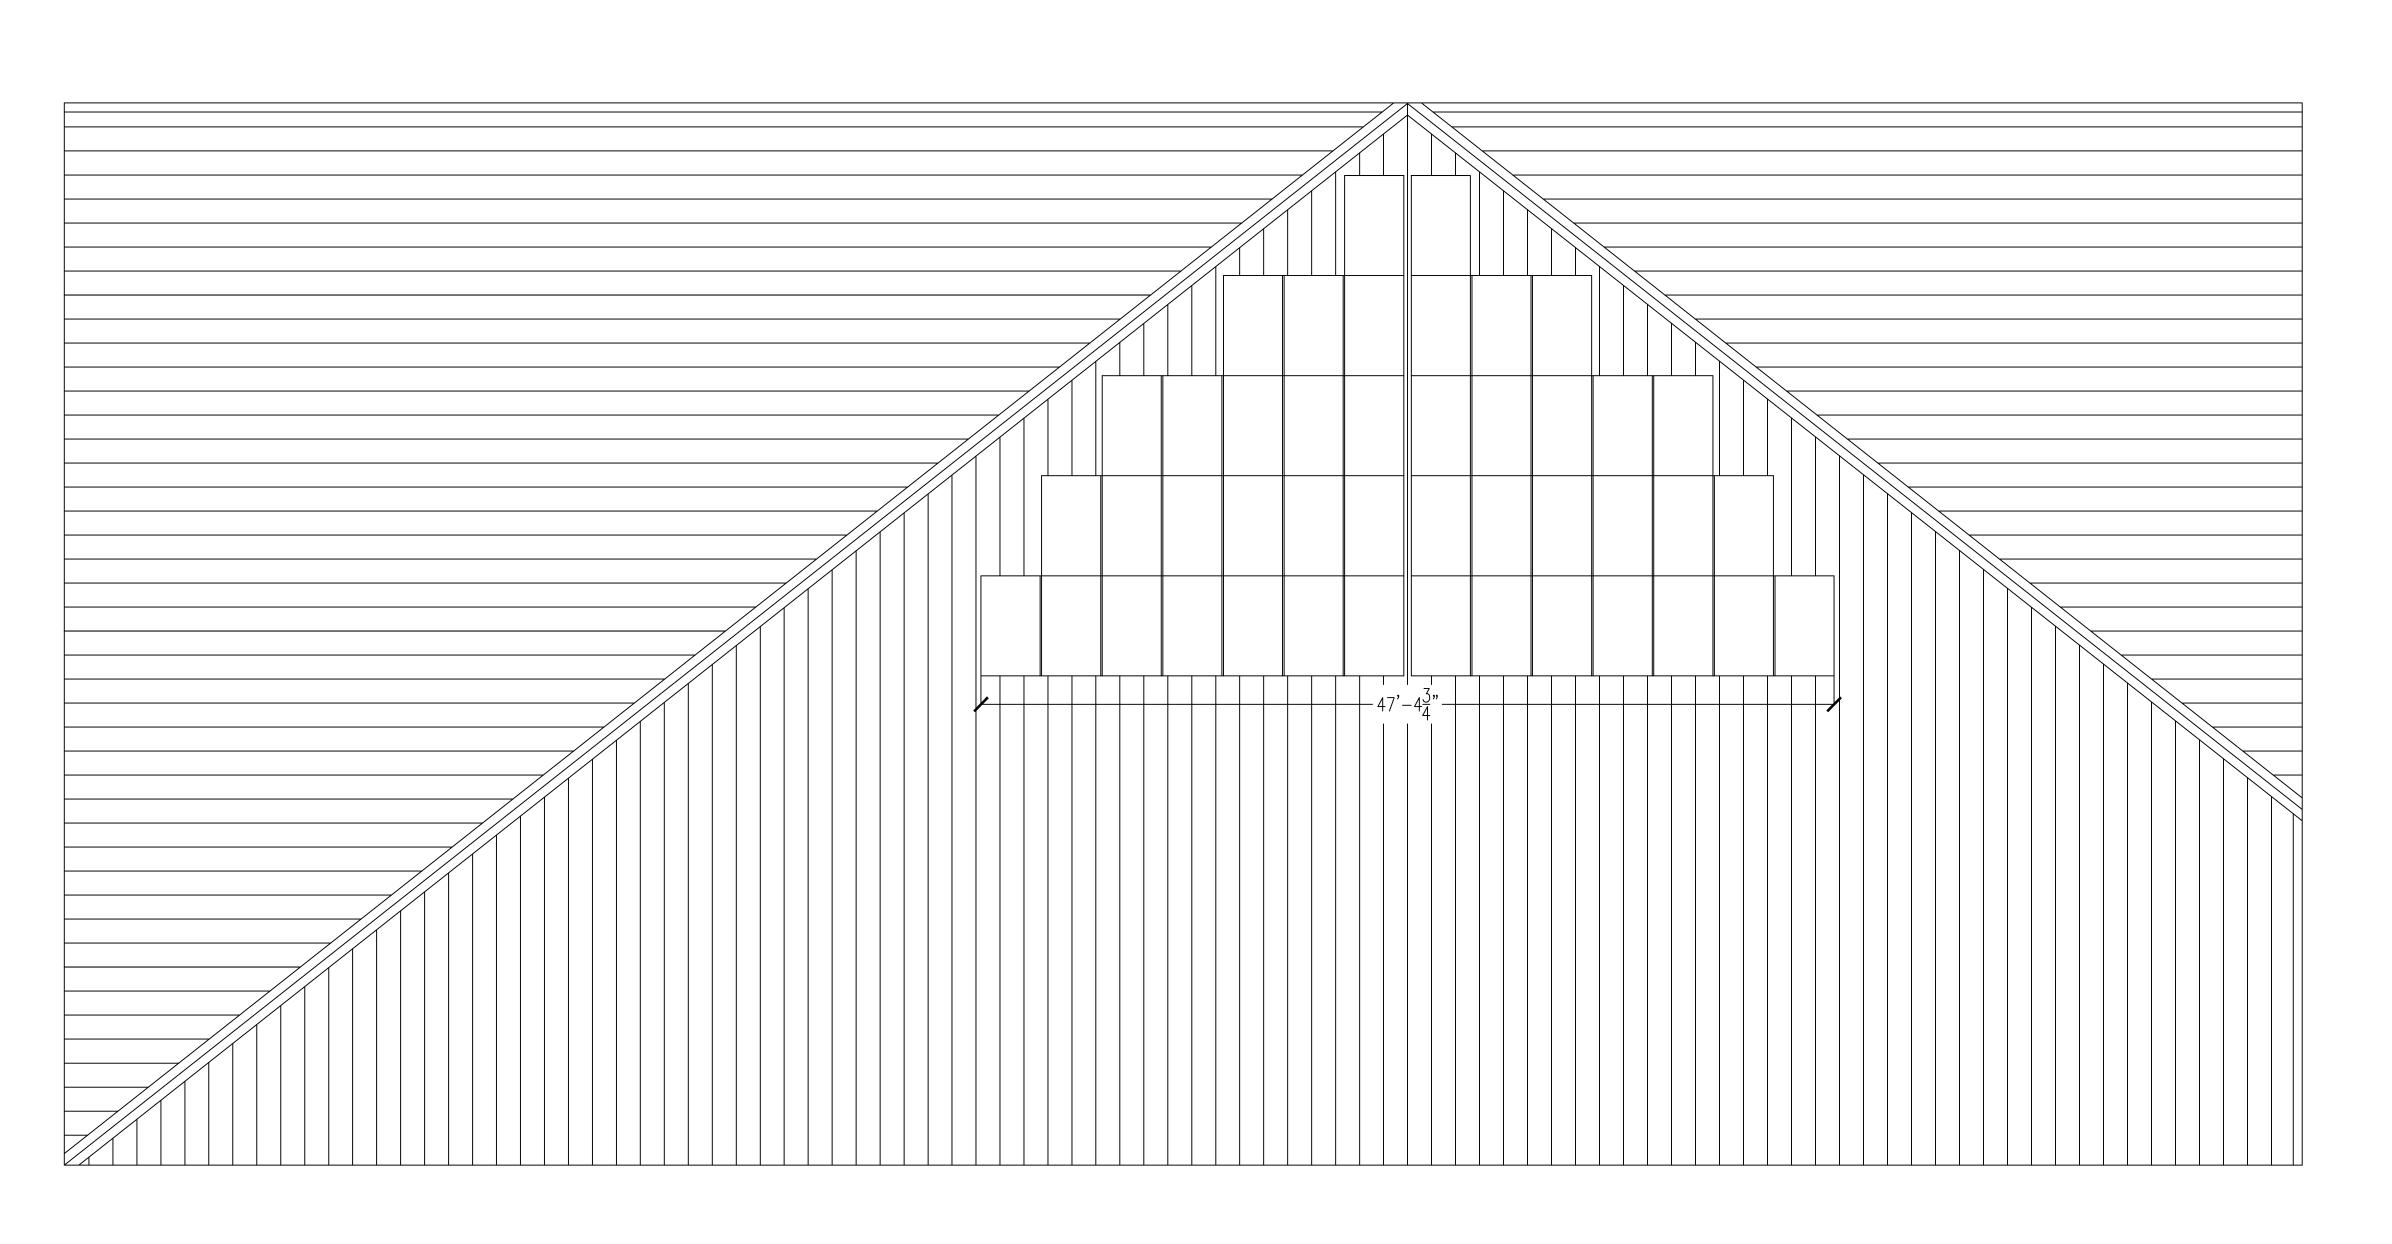

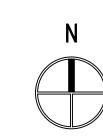

ELECTRIC, I ELECTRIC, I ELECTRIC, I ELECTRICAL, POWER & TECHNOLOGY SE 111 SW Columbia Street, Ste 48 Portland, OR 97201 main 503.419.3330 fax 503.419.3333 www.christenson.com

Revisions:

PONZI VINEYARDS - COLLINA DEL SOGNO
PHOTOVOLTAIC PROJECT
19500 SW Mountain Home Rd.
Sherwood, Oregon 97140

Sheet Title:
LAYOUT +
ELEVATION

Date: 02/24/2012
CEI Project No.
CEI Project Manager: JZ
Designed By: KK
Drawn By: KK
Checked By:
Project Type: 230

Sheet Number:

DESIGN

Α

# SYSTEM DESCRIPTION

1 ARRAY, 44 MODULES TOTAL

1 INVERTER (POWER-ONE AURORA TRIO 10kW) - 480VAC/14A)

SIZE - 9,900 W DC STC

EST. ANNUAL PRODUCTION - 11,393 KWh AC

# SOURCE CIRCUIT

PHOTOVOLTAIC MODULE:

SOLARWORLD SW 225 POLY, 225 W STC

 $Voc = 36.8V (40.9V @ -8^{\circ}C - ASHRAE MEAN EXTREME LOW TEMP)$ 

Vmp = 29.5V (22.8V @ 37°C - ASHRAE 0.4% HIGH TEMP)

lsc = 8.2A

Imp = 7.6A

# PHOTOVOLTAIC ARRAY

44 MODULES, 11 MODULES/STRING (4 STRINGS TOTAL)

 $Voc = 450.2V @ -8^{\circ}C$ 

Vmp = 324.5V TYPICAL (251.3V @ 37°C)

lsc = 8.2A

Imp = 7.6A

# OUTPUT CIRCUITS

- MODULES MOUNTED TO UNIRAC RACKING SYSTEM ATTACHED TO STANDING SEAM ROOF.
- SOURCE CIRCUIT CONDUIT ENTERS BUILDING AT ARRAY. CONDUIT IS EMT WITH BOTTOM EDGE NO LESS THAN 4" FROM ROOF DECK OUTSIDE AND TOP EDGE NO LESS THAN 18" FROM BOTTOM OF ROOF DECK.
- INVERTER WITH DC DISCONNECT & AC DISCONNECT MOUNTED INSIDE ON SOUTHEAST WALL.
- INVERTER OUTPUT CONDUIT ROUTED TO OUTDOOR PV
   PRODUCTION METER (ADJACENT TO EXISTING UTILITY METER)

   OUTSIDE ON THE EAST WALL OF BUILDING.
- POINT OF COMMON CONNECTION (POCC) LOCATED IN EXISTING ELECTRICAL SUBPANEL.

# ELECTRICAL NOTES FOR NEW PV SYSTEM

- THIS PROPOSED SOLAR ELECTRIC SYSTEM IS INTENDED TO
  OPERATE IN PARALLEL DURING THE DAY WITH POWER RECEIVED
  FROM THE UTILITY SERVICE PROVIDER.
- ALL EQUIPMENT IS UL APPROVED AND IDENTIFIED FOR USE IN THE PV SYSTEM.
- THIS SYSTEM IS INTENDED TO CONNECT TO THE EXISTING
  FACILITY POWER SYSTEM AT ONE POINT, POINT OF COMMON
  COUPLING (POCC). THIS CONNECTION SHALL BE IN COMPLIANCE
  WITH THE NEC ARTICLE 705.12 "POINT OF CONNECTION".

## WIRING + WIRING METHODS

ALL WIRING METHODS AND INSTALLATION PRACTICES CONFORM TO THE NATIONAL ELECTRIC CODE, OREGON SOLAR INSTALLATION SPECIALTY CODE, AND OTHER APPLICABLE LOCAL CODES.

# GROUNDING

SEE E.2 — ELECTRICAL DIAGRAM FOR MORE GROUNDING INFORMATION.

# GROUND FAULT PROTECTION

PHOTOVOLTAIC INVERTERS ARE EQUIPPED WITH DC GROUND FAULT PROTECTION TO REDUCE FIRE HAZARDS. INVERTERS ARE ALSO EQUIPPED WITH ANTI-ISLANDING CIRCUITRY.

# DISCONNECTING MEANS

MEANS ARE PROVIDED TO DISCONNECT ALL CURRENT CARRYING CONDUCTORS OF THE PHOTOVOLTAIC POWER SOURCE FROM ALL OTHER CONDUCTORS AT THE LOCATION.

# REQUIRED SAFETY SWITCHES, LABELS + MARKINGS

REQUIRED SAFETY SIGNS AND LABELS ARE PERMANENTLY ATTACHED BY ADHESIVE, OR OTHER MECHANICAL MEANS. LABELS COMPLY WITH ARTICLE 690 OF THE NEC OR OTHER APPLICABLE STATE AND LOCAL CODES. SEE E.3 — SIGNAGE FOR MORE DETAILS.

ELECTRIC, IN ELECTRIC, IN ELECTRIC, SER 111 SW Columbia Street, Ste 488 Portland, OR 97201 main 503.419.3300 fax 503.419.3333 www.christenson.com

Revisions:

OTOVOLTAIC PROJECT

10 SW Mountain Home Rd.

Sheet Title:
ELEC NOTES +

Date: 02/24/2011
CEI Project No.

CEI Project Manager: Designed By:


Drawn By: Checked By:

Project Type:

Sheet Number:

E.1

1 ELECTRICAL NOTES	
E.1 SCALE: N/A	

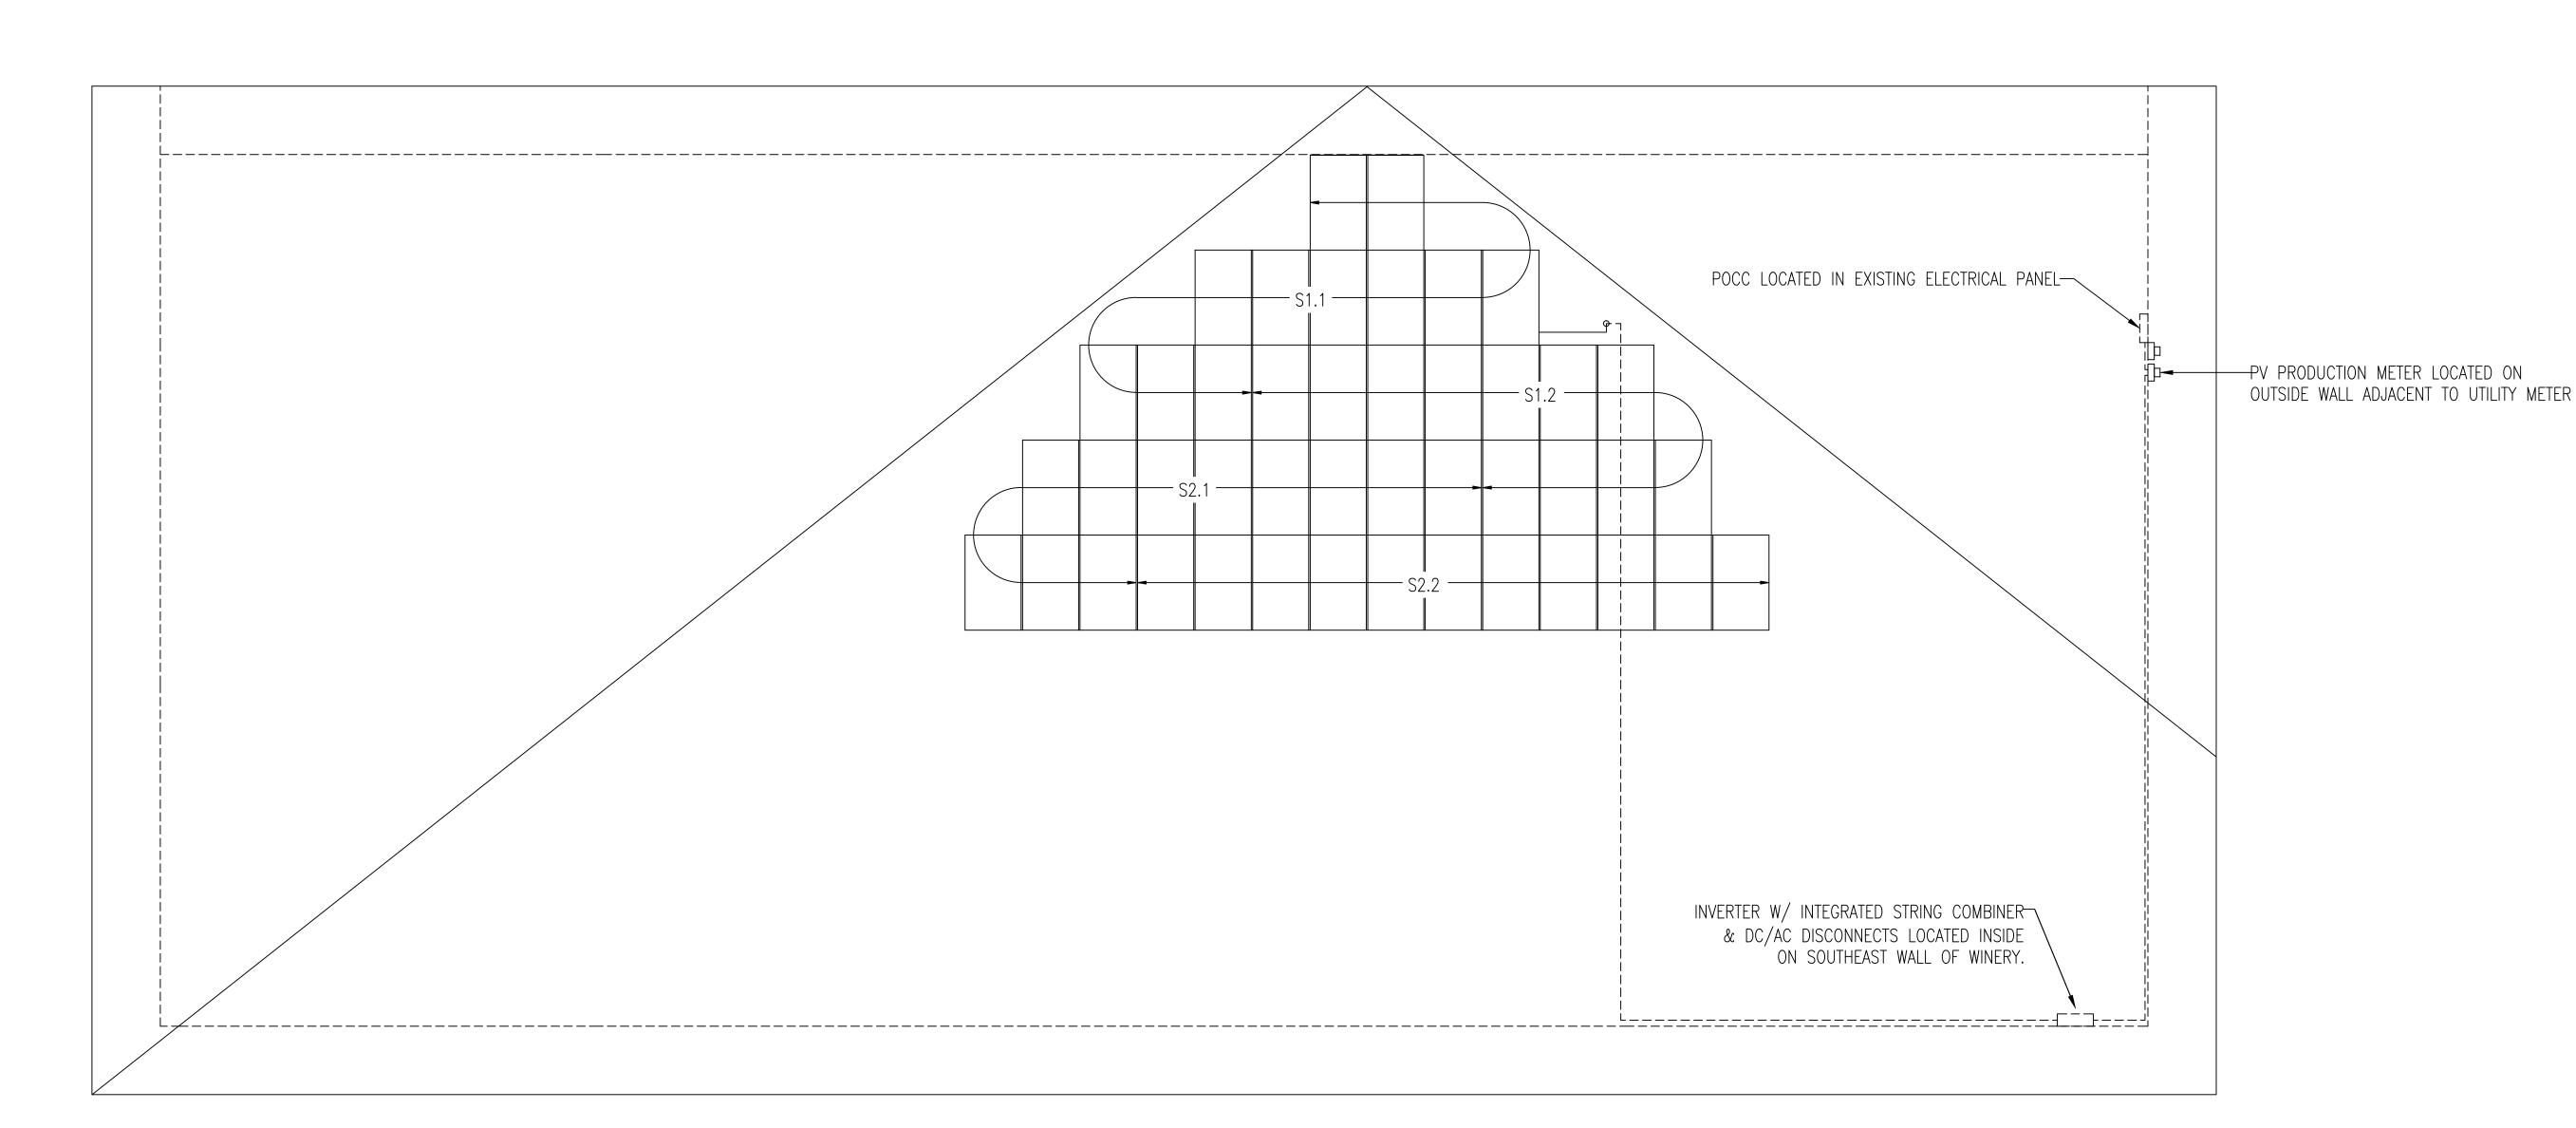

MODULE TYPE SOLARWORLD 225 POLY
QUANTITY 44 MODULES
SOURCE CIRCUITS (4) TOTAL
JUNCTION BOXES N/A


INVERTERS

(1) TOTAL

SYSTEM DESCRIPTION

2 ELECTRICAL PLAN SCALE: 3/16" = 1' - 0"

DESIGN

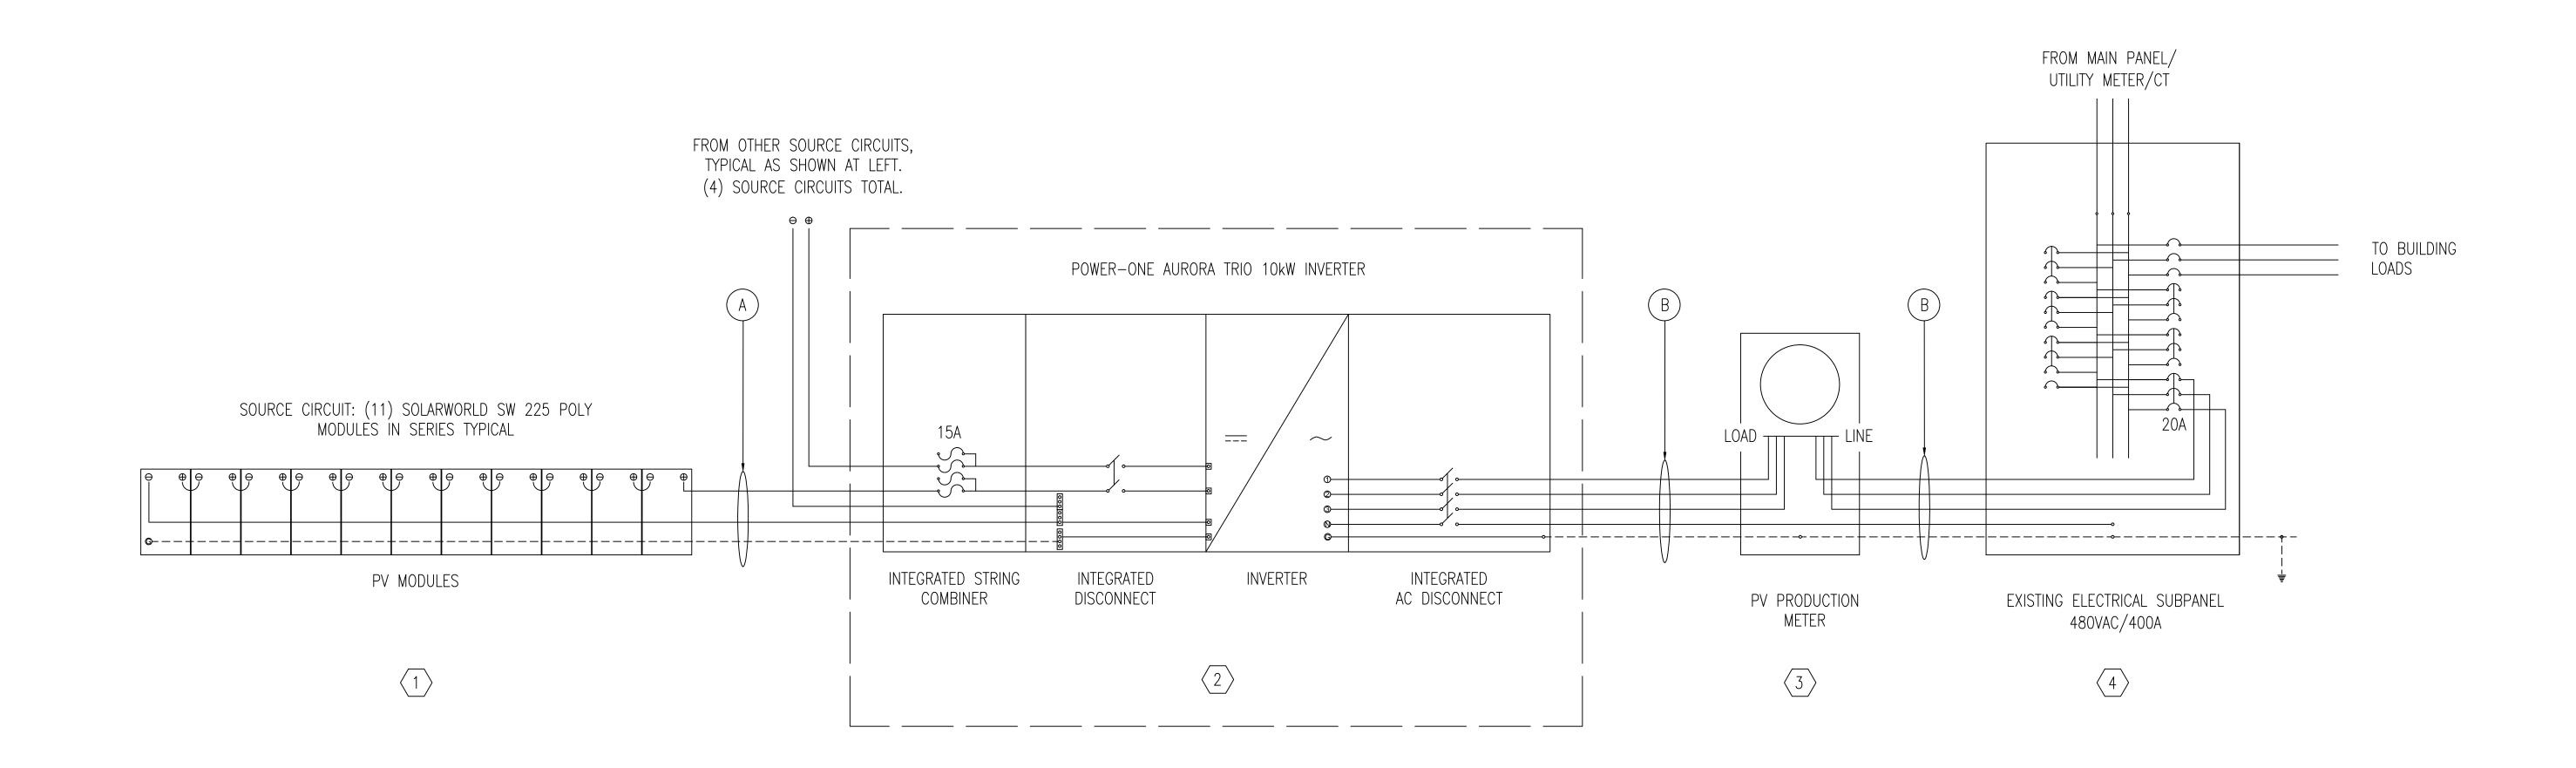

# SHEET NOTES

- SOLARWORLD 225 POLY PV MODULES W/ MC TYPE 4 CONNECTORS.

  GROUNDING W/ WEEB GROUNDING CLIPS TO RAILS, GROUNDING LUGS ON RAILS AND CONNECTED TO INVERTER GROUND LUG. FURNISHED BY CEI.
- POWER-ONE AURORA TRIO 10kW INVERTER W/ INTEGRATED STRING COMBINER & DC/AC DISCONNECTS (PVI-10.0-I-OUTD-S2-US-480-NG W/STRING COMBINER) (1) TOTAL INVERTERS. SEE DATASHEET FOR DETAILED BLOCK DIAGRAM. FURNISHED BY CEI.
- PV PRODUCTION METER (COOPER B-LINE 117TB) METER BASE TO BE FURNISHED BY CEI, METER TO BE FURNISHED & INSTALLED BY UTILITY.
- EXISTING ELECTRICAL SUBPANEL (SQUARE D NF PANELBOARD) 480Y/277V, 600A, 15A/3P CIRCUIT BREAKER (SQUARE D EDB34015) FOR PV SYSTEM FURNISHED BY CEI.

TABLE A: PV SOURCE CIRCUIT CONDUCTOR & CONDUIT IDENTIFICATION											
CONDUCTOR LOCATION A	# OF MODULES IN SERIES	Isc (A)	Imp (A)	Voc (VDC)	Vmp (VDC)	MAX. ONE WAY LENGTH (FT.)	VOLTAGE DROP %	CURRENT CARRYING CONDUCTOR SIZE	CONDUCTOR TYPE	BONDING CONDUCTOR	CONDUIT
MODULES TO INVERTER	11	8.20	7.60	450.2	324.5	110'-0"	0.60%	#10	USE-2	#6	FREE AIR> 1" EMT

TABLE B: INVERTER OUTPUT CIRCUIT CONDUCTOR & CONDUIT IDENTIFICATION									
CONDUCTOR LOCATION	NOMINAL VOLTAGE (VAC)	PHASES	GENERATION AMPACITY (A)	DISTANCE	VOLTAGE DROP %	CURRENT CARRYING CONDUCTOR SIZE	CONDUCTOR TYPE	GROUNDING CONDUCTOR	CONDUIT
В	480	3	14.0	60'-0"	0.50%	#12	THWN-2	#6	1" EMT

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Revisions:

21 VINEYARDS - COLLINA DEL SOGNO PHOTOVOLTAIC PROJECT 19500 SW Mountain Home Rd. Sherwood, Oregon 97140

Sheet Title: **ELEC DIAGRAM** 

Date: 02/24/2012

CEI Project No.

CEI Project Manager: JZ

Designed By: KK


Drawn By: KK

Checked By:

Sheet Number:

Project Type:

E.2

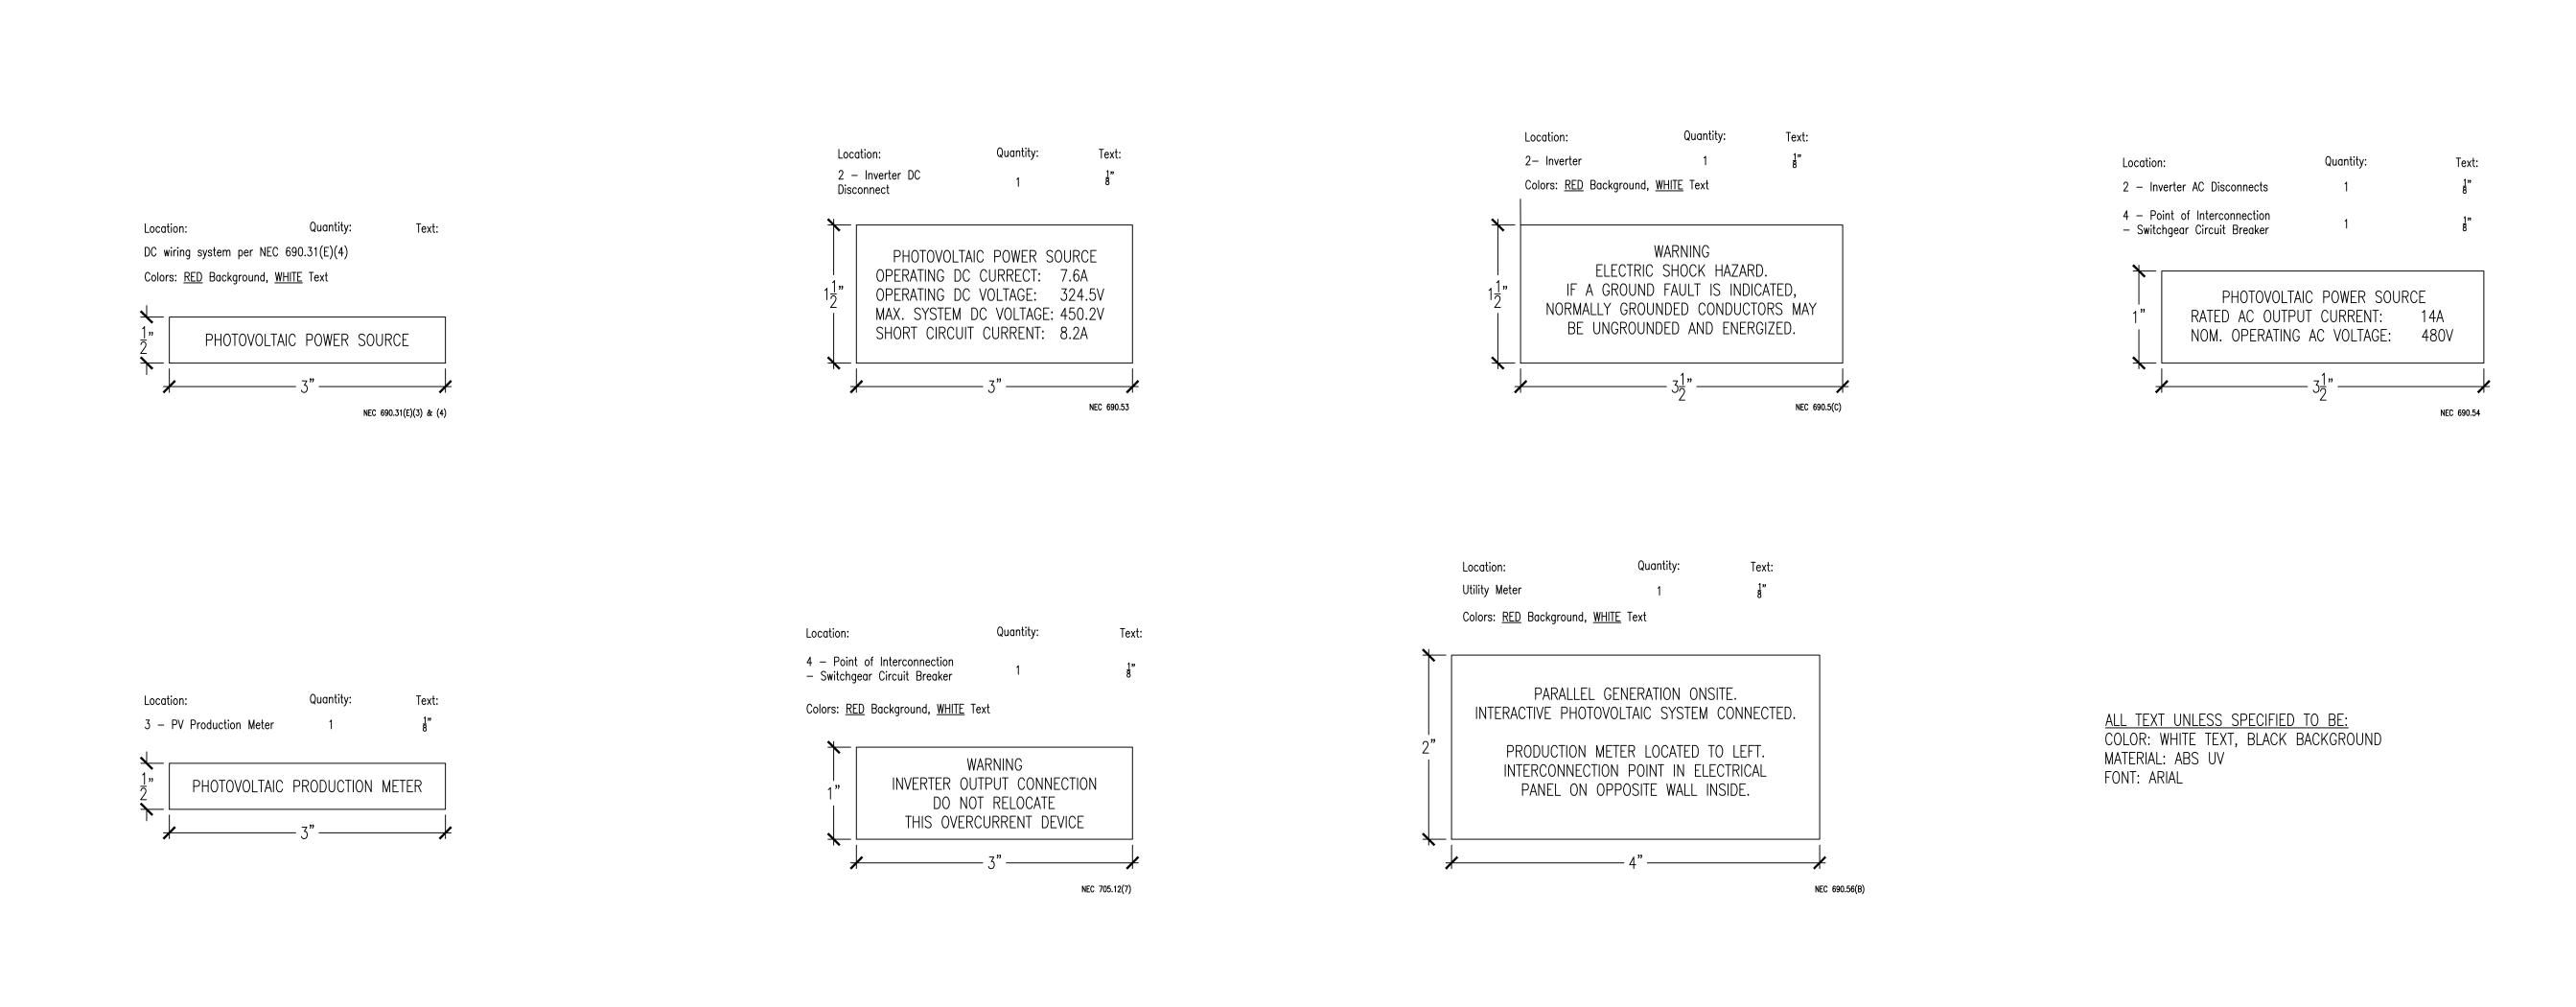

1 SIGNAGE SCALE: 1" = 1" ELECTRIC, INC.
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Sheet Title:


Date: 02/24/2012 CEI Project No.

CEI Project Manager:
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E.3



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Sheet Title:
RACKING LAYOUT

Date: 02/24/2012

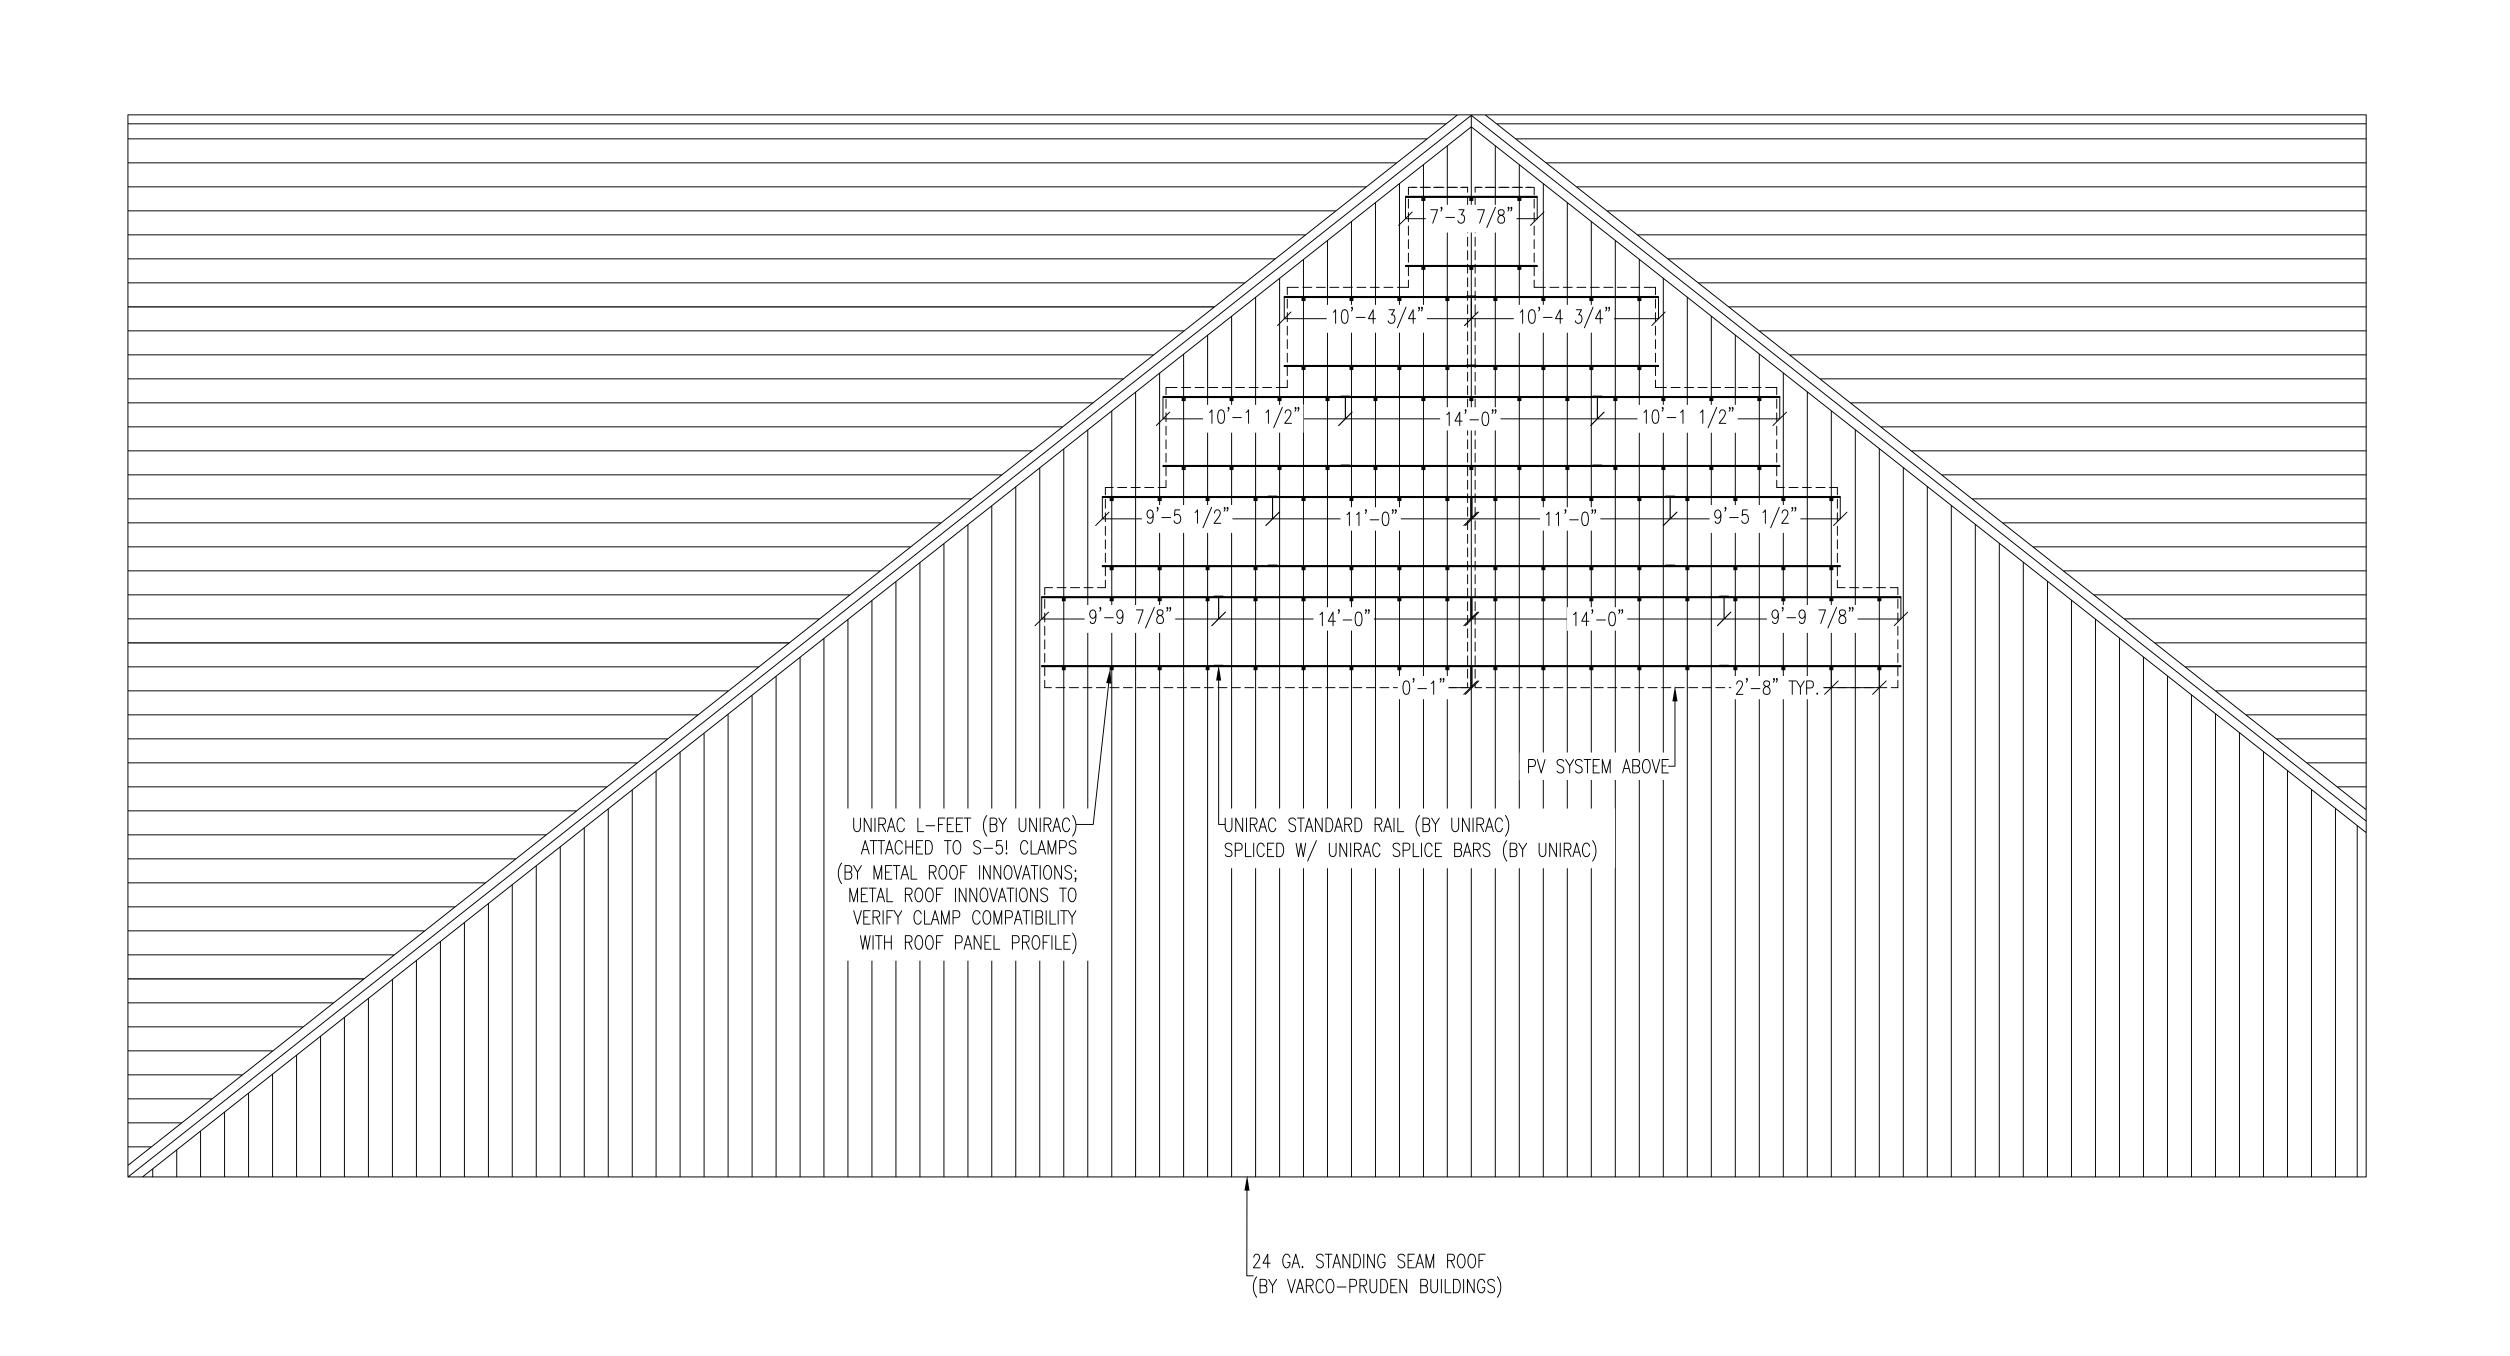CEI Project No.

CEI Project Manager: JZ

Designed By: KK


Drawn By:
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Project Type:

Sheet Number:

DESIGN

S.1

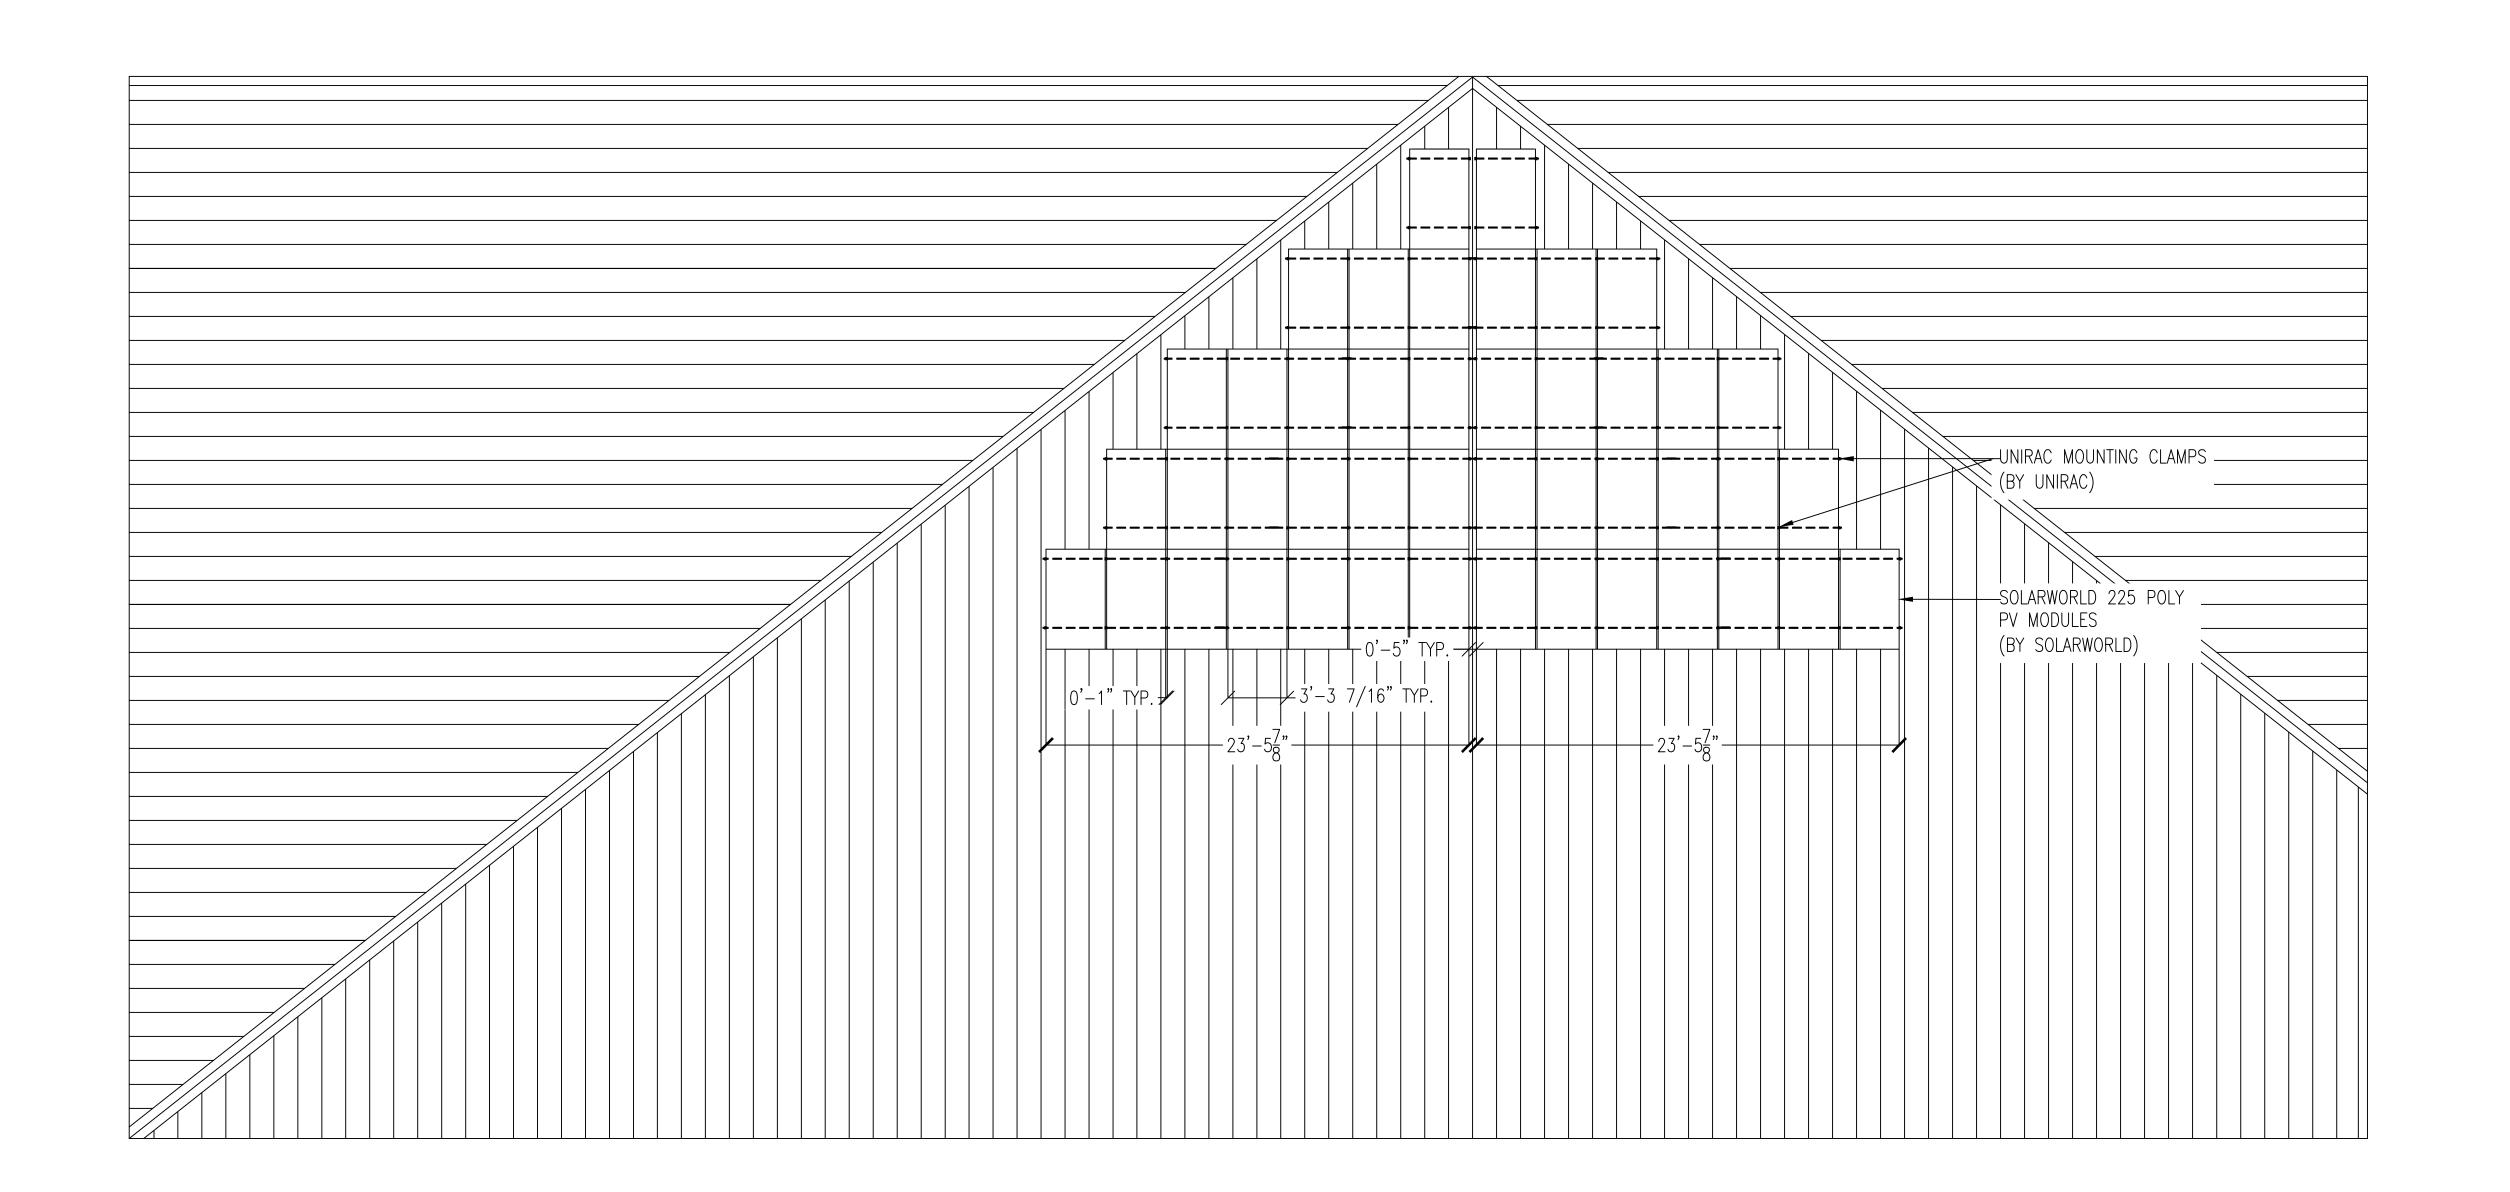

SYSTEM DESCRIPTION					
MODULE TYPE	SOLARWORLD 225 POLY				
QUANTITY	44 MODULES				
SYSTEM SIZE	9.9 kW DC STC				
TILT ANGLE	17°				
AZIMUTH	180°				





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Sheet Title:

MODULE LAYOUT

Date: 02/24/2012

CEI Project No.

CEI Project Manager: JZ


Designed By: KK

Designed By:
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Checked By:

Checked By: Project Type:

Sheet Number:

S.2

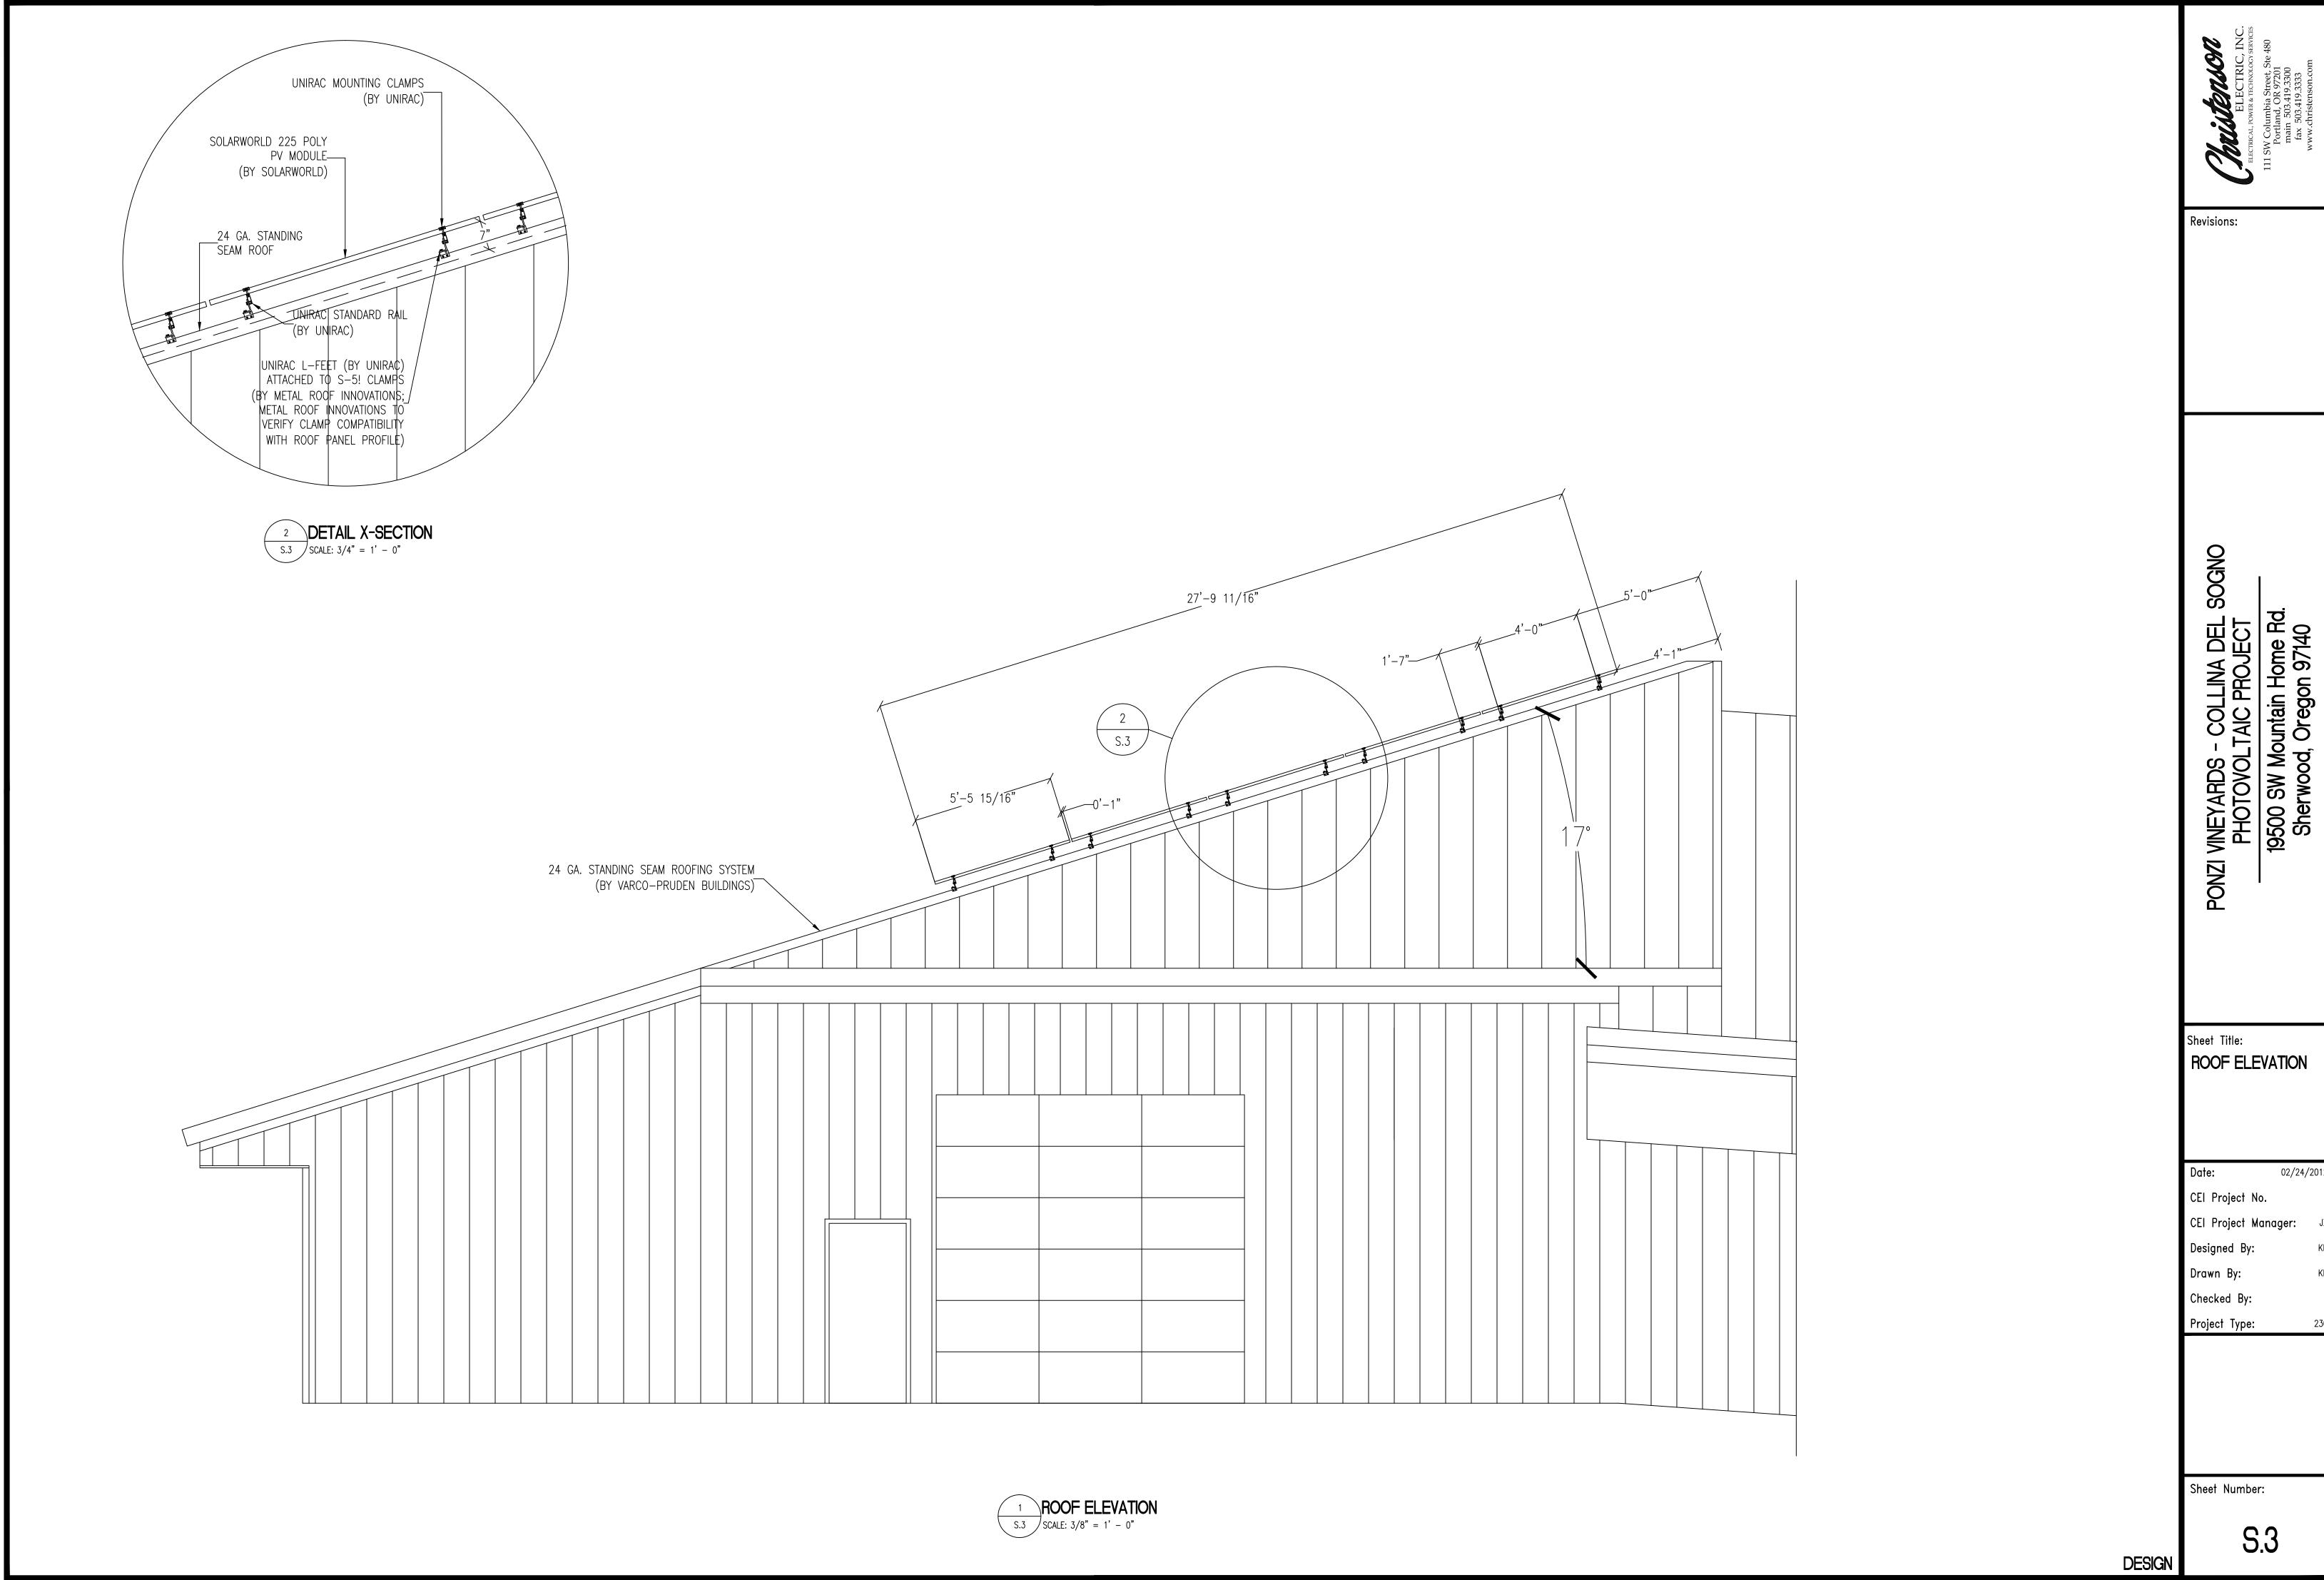

02/24/2012